


NW 1/4, NE 1/4, SECTION 32 TOWNSHIP 28 N, RANGE 05 E SNOHOMISH COUNTY, WASHINGTON

KAZZIEP SHORT PLAT COVER SHEET

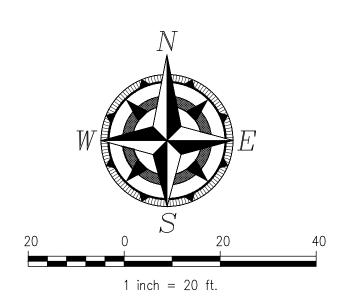

VERTICAL DATUM

PER OPUS SOLUTION ON SITE.

HORIZONTAL DATUM

S 88°22'50" E ALONG THE NORTH LINE OF THE NORTH EAST 1/4 SECTION 32 TOWNSHIP 28 NORTH, RANGE 5 EAST. (WSPNZ 2007)

| SITE CHARACTERISTICS | | | | | |
|---|--|---|-------|--|---|
| LOT AREA 35,7 | 09 SF 0.82 A | с | | | |
| | | AC | | UTILITIES | |
| PERVIOUS (EXISTING) 31,6 | 24 SF 0.726 | AC | | | HOMISH COUNTY PUD |
| DEV DRIVEWAY/WALKWAYS 4,4 | 365 SF 0.192 A 414 SF 0.101 A 779 SF 0.293 A | <u>c</u> | | WATER SILV | ET SOUND ENERGY ER LAKE WATER AND SEWER DISTRICT ER LAKE WATER AND SEWER DISTRICT |
| PERVIOUS (LANDSCAPING) 22, | 930 SF 0.527 | AC | | <u>SURVEYOR</u> | GREENE LAND SURVEYING 7408 164TH ST SW |
| NEW HARD SURFACE 8,8 | 954 SF 325 SF 779 SF >>10,000 | | | | LYNNWOOD, WA 98087 (TEL)206–498–0979 Guy@GreeneSurveying.com |
| | | | | <u>APPLICANT/OWNER</u> | KAZZIEP, LLC 3904 — 214TH ST SW MOUNTLAKE TERRACE, WA 98043 |
| | | | | AGENT | TONY AVERSANO 4223 NE 203RD PLACE SEATTLE, WA 98155 (TEL) 206–234–9105 |
| | | | | PROJECT ENGINEER | J.C. MCDONNELL ENGINEERING, PC 6608 216TH ST SW, SUITE 306 MOUNTLAKE TERRACE, WA 98043 (TEL) 425-744-0916 (FAX) 425-744-0946 john@jcmcdon.com |
| | | | | LEGAL DESCRIPTION: | _ |
| | | | | PLAT THEREOF RECO | OD WEST DIVISION 6, ACCORDING TO THE RDED IN VOLUME 47 OF PLATS, PAGE 3, MISH COUNTY, WASHINGTON. |
| | | | | REPORT AND THEREF | ONDUCTED WITHOUT THE BENEFIT OF TITLE ORE DOES NOT PURPORT TO SHOW ALL TIONS, RESERVATIONS, AND RIGHTS OF |
| | r | | | SITUATE IN THE COU | NTY OF SNOHOMISH, STATE OF WASHINGTON. |
| | | GRADING QUANTITIE | S: | LAND USE/ZONING: | |
| | | CUT: Cu.Yds. | | LDR | |
| | r | FILL: CU.Yds. (grading quantities are rough calculati | | <u>TAX ACCOUNT NO.(S):</u> 00747900004900 | <u>SITE ADDRESS:</u> |
| OVER SHEET KISTING CONDITIONS TOPOGRAPHIC AND BOUNDAF RELIMINARY CLEARING, GRADING, AND T.E.S.C. PL | | NOT ACCOUNT FOR SOIL SWELLING & SHRINK | AGE.) | 00777300004300 | 2720 – 132ND ST SE MILL CREEK, WA 98012 |
| RELIMINARY DRAINAGE AND UTILITY PLAN | 5 " * | EXCESS EXCAVATED MATERIAL SHAL REMOVED FROM THE SITE. ANY SOIL REMOVED FROM THE SITE HAULED TO A CITY APPROVED SITE. | | | |
| | | | | | COVER SHEET |
| | C.McD(| ONNELL | | KAZ | ZZIEP SHORT PLAT |
| | | | | | ON 32TOWNSHIP 28 N, RANGE 05 E MISH COUNTY, WASHINGTON |

DRAWN BY

TJW

DATE REV. BY

09/18/2018

DRAWING FILE NAME CHK. BY

6063-Filbert Road 5-Unit.dwg

DATE PROJECT MANAGER SCALE

6063

F.B. NO. JOB NO.

J.C. McDonnell AS SHOWN

SHT. NO.

C1 OF 4


SHEET INDEX.


SHEET C1 OF 4 COVER SHEET C2 OF 4 EXISTIN SHEET C3 of 4 PRELIM SHEET C4 of 4 PRELIM

UTILITY CONFLICT NOTE:


THE CONTRACTOR SHALL BE RESPONSIBLE FOR VERIFYING THE LOCATION, DIMENSION, AND DEPTH OF ALL EXISTING UTILITIES WHETHER SHOWN ON THESE PLANS OR NOT, BY POTHOLING THE UTILITIES AND SURVEYING THE HORIZONTAL AND VERTICAL LOCATION PRIOR TO CONSTRUCTION. THIS SHALL INCLUDE CALLING UTILITY LOCATE @ 1-800-424-5555 AND THEN POTHOLING ALL OF THE EXISTING UTILITIES AT LOCATIONS OF NEW UTILITY CROSSINGS O PHYSICALLY VERIFY WHETHER OR NOT CONFLICTS EXIST. LOCATIONS OF SAID UTILITIES AS SHOWN ON THESE PLANS ARE BASED UPON THE UNVERIFIED PUBLIC INFORMATION AND ARE SUBJECT TO VARIATION. IF CONFLICTS SHOULD OCCUR, THE CONTRACTOR SHALL CONSULT J.C. MCDONNELL ENGINEERING, PC TO RESOLVE ALL PROBLEMS PRIOR TO PROCEEDING WITH CONSTRUCTION.



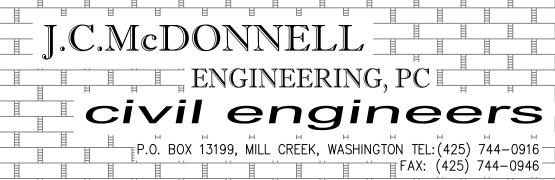

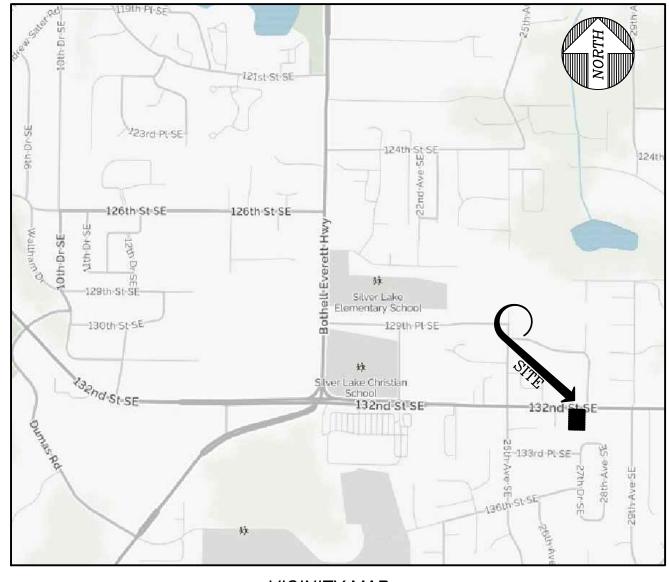

VICINITY MAP SCALE 1'' = 1000'

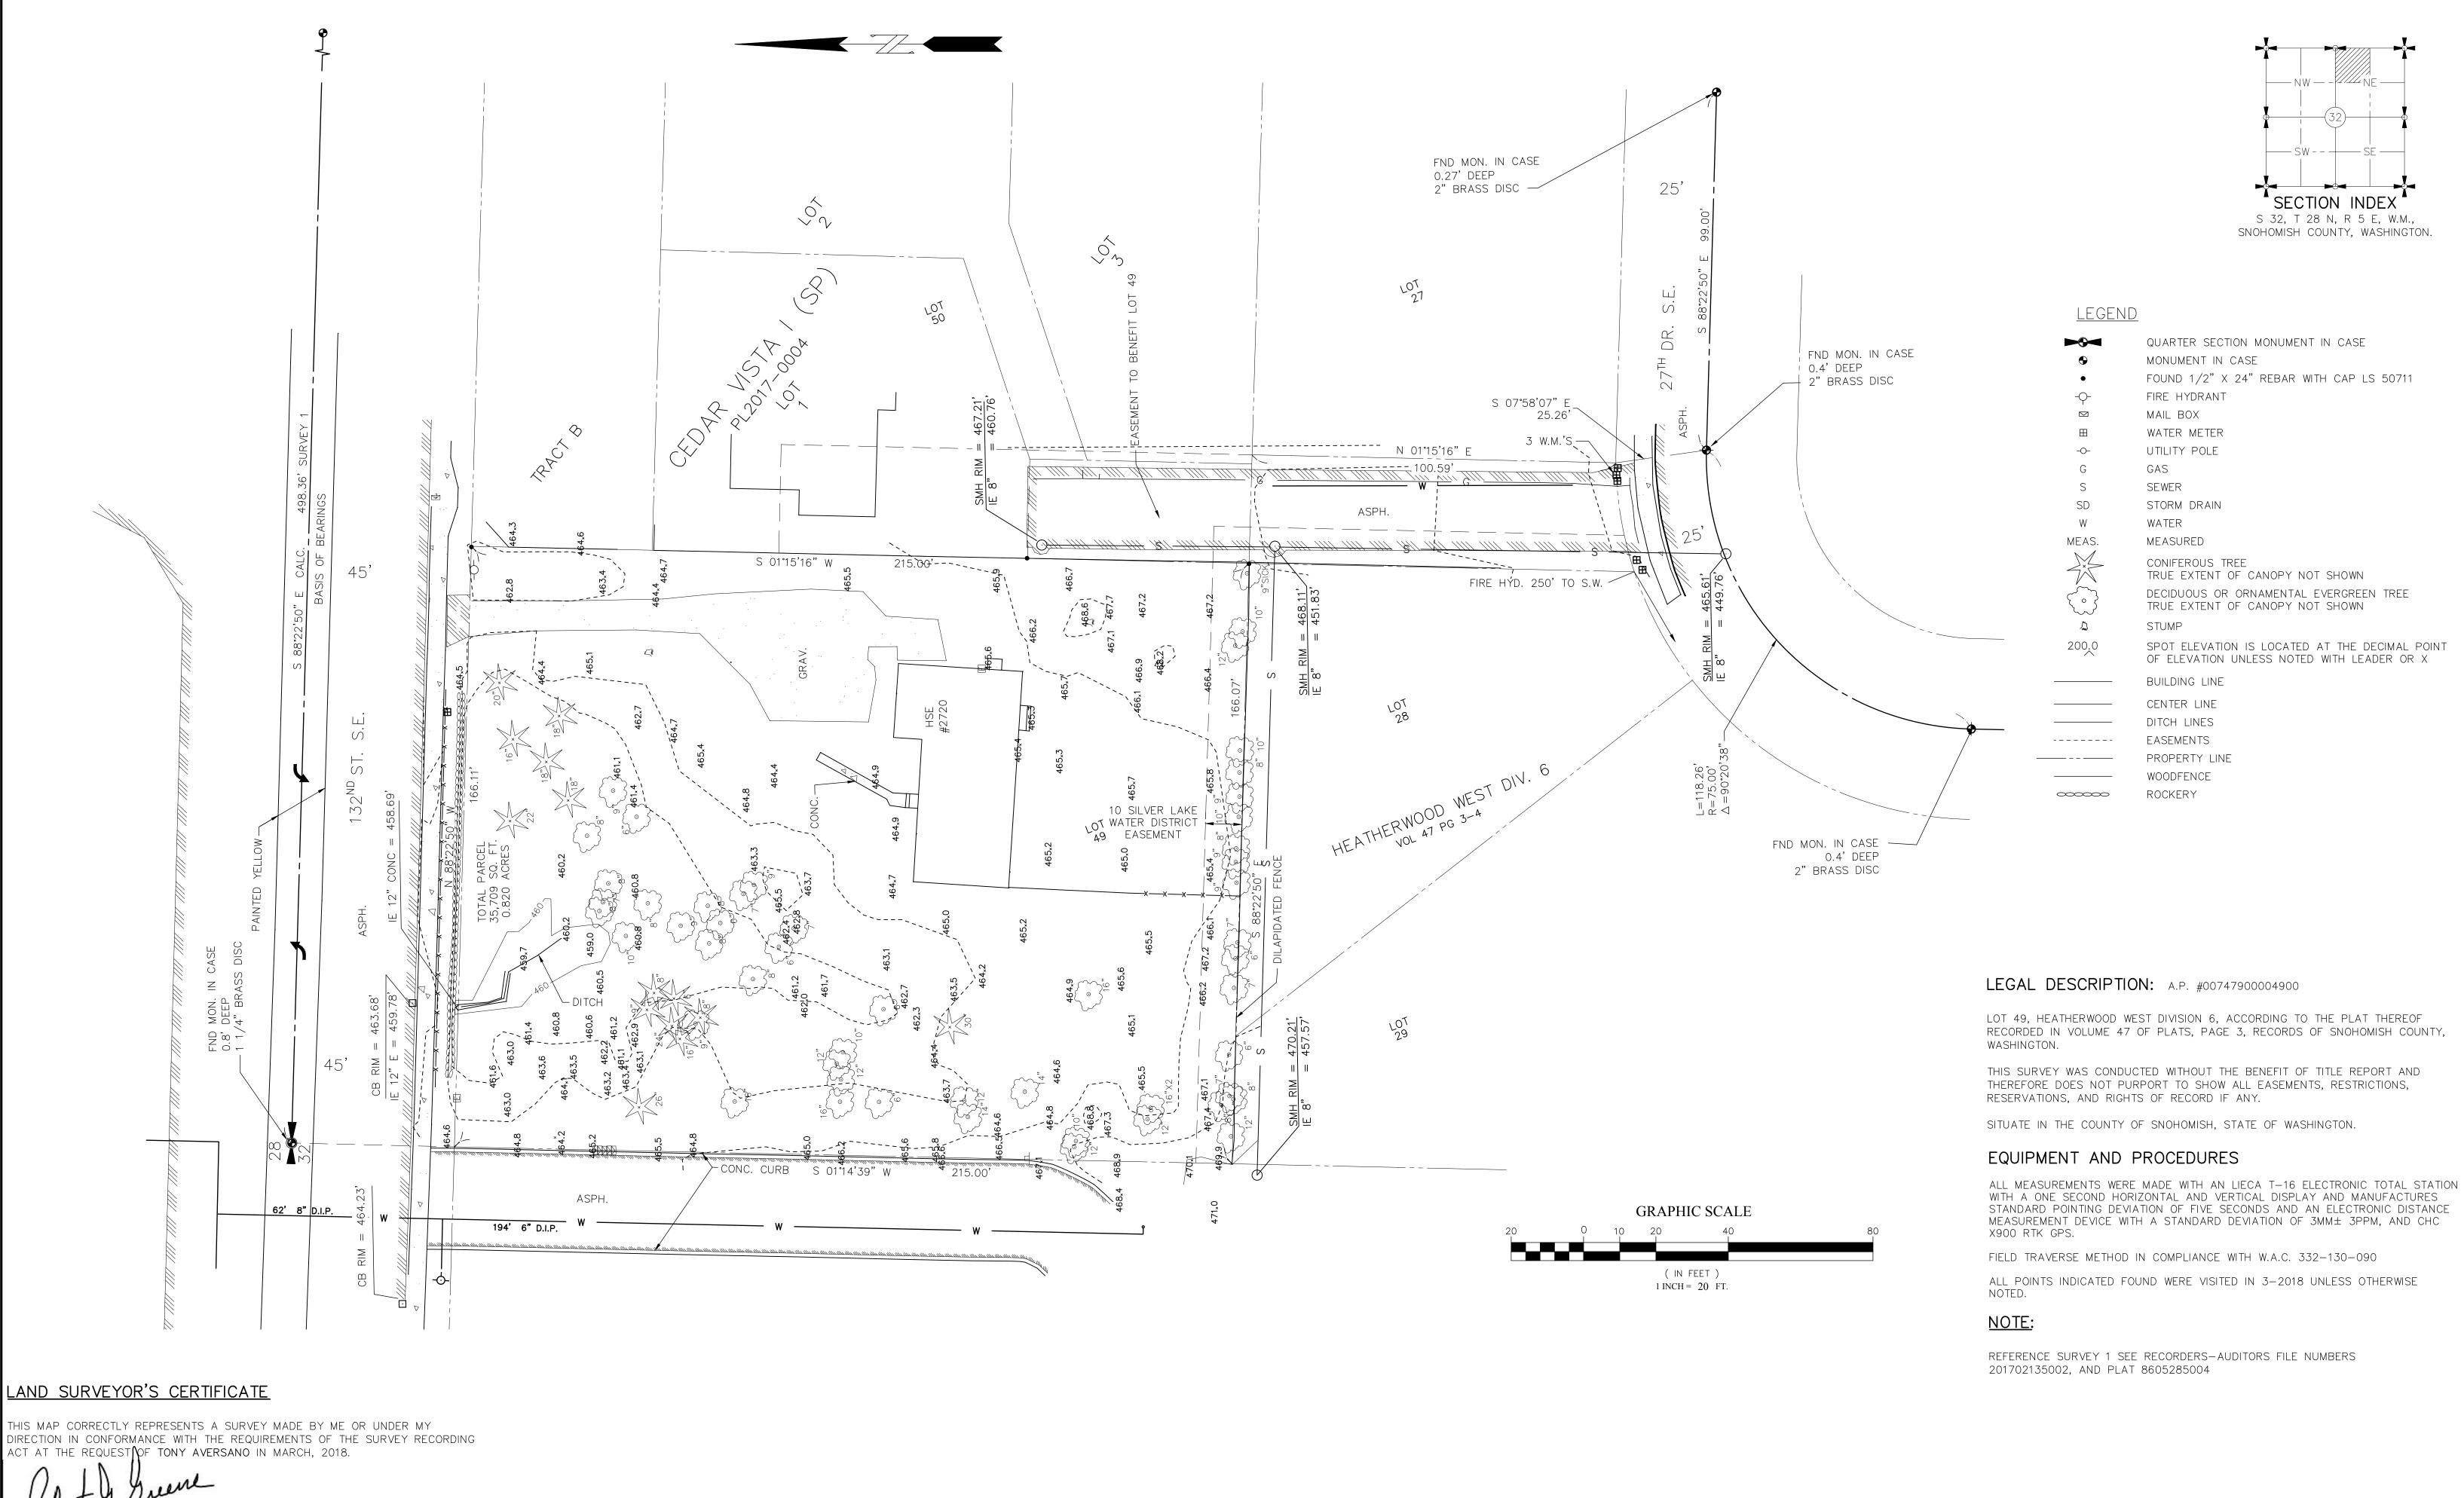

CERTIFICATE NO. 29539


| NIII | 12/1/1 | 1//// | 111121211 | WAXE . |
|-------|---------|----------------|---------------------|--------|
| | Lat | HUS | X | 42 |
| | 5/4 | JF WA | SPECE | N N |
| | ST | E | PERCTON BEINGTON | m18 |
| Pa | 1 | 1 | | ð j |
| | 10.55 N | 29539 G/STE | BE SE | S'OR |
| anne. | num | AL LA | NOS | m |

REVISIONS RGG GENERAL NOTES DESIGNED BY DRAWN BY HORIZONTAL DATUM: S 88°22'50" E ALONG THE NORTH LINE OF THE NORTH EAST 1/4 SECTION 32 TOWNSHIP 28 NORTH, RANGE 5 EAST. (WSPNZ 2007) DATE PRINTED VERTICAL DATUM: NAVD 1988 PER OPUS SOLUTION ON SITE. 1" = 20' SCALE DATA-C

F.B. NO.






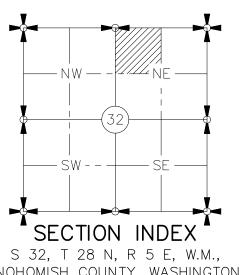


| KEZZIEP PRELIMINARY | SHORT PLA | | |
|---------------------|------------|--|--|
| EXISTING CONDIT | IONS | | |
| HOUSE #2720 1321 | ND ST S.E. | | |
| FOR | | | |
| KAZZIEP LLC | | | |

| JOB NO | • | | |
|-------------|-------|------|--|
| 2 | 018.1 | 8 | |
| DRAWING NO. | | | |
| 18.18 | BKAZ | ZIEP | |
| SHEET | OF | | |
| | C2 | 4 | |

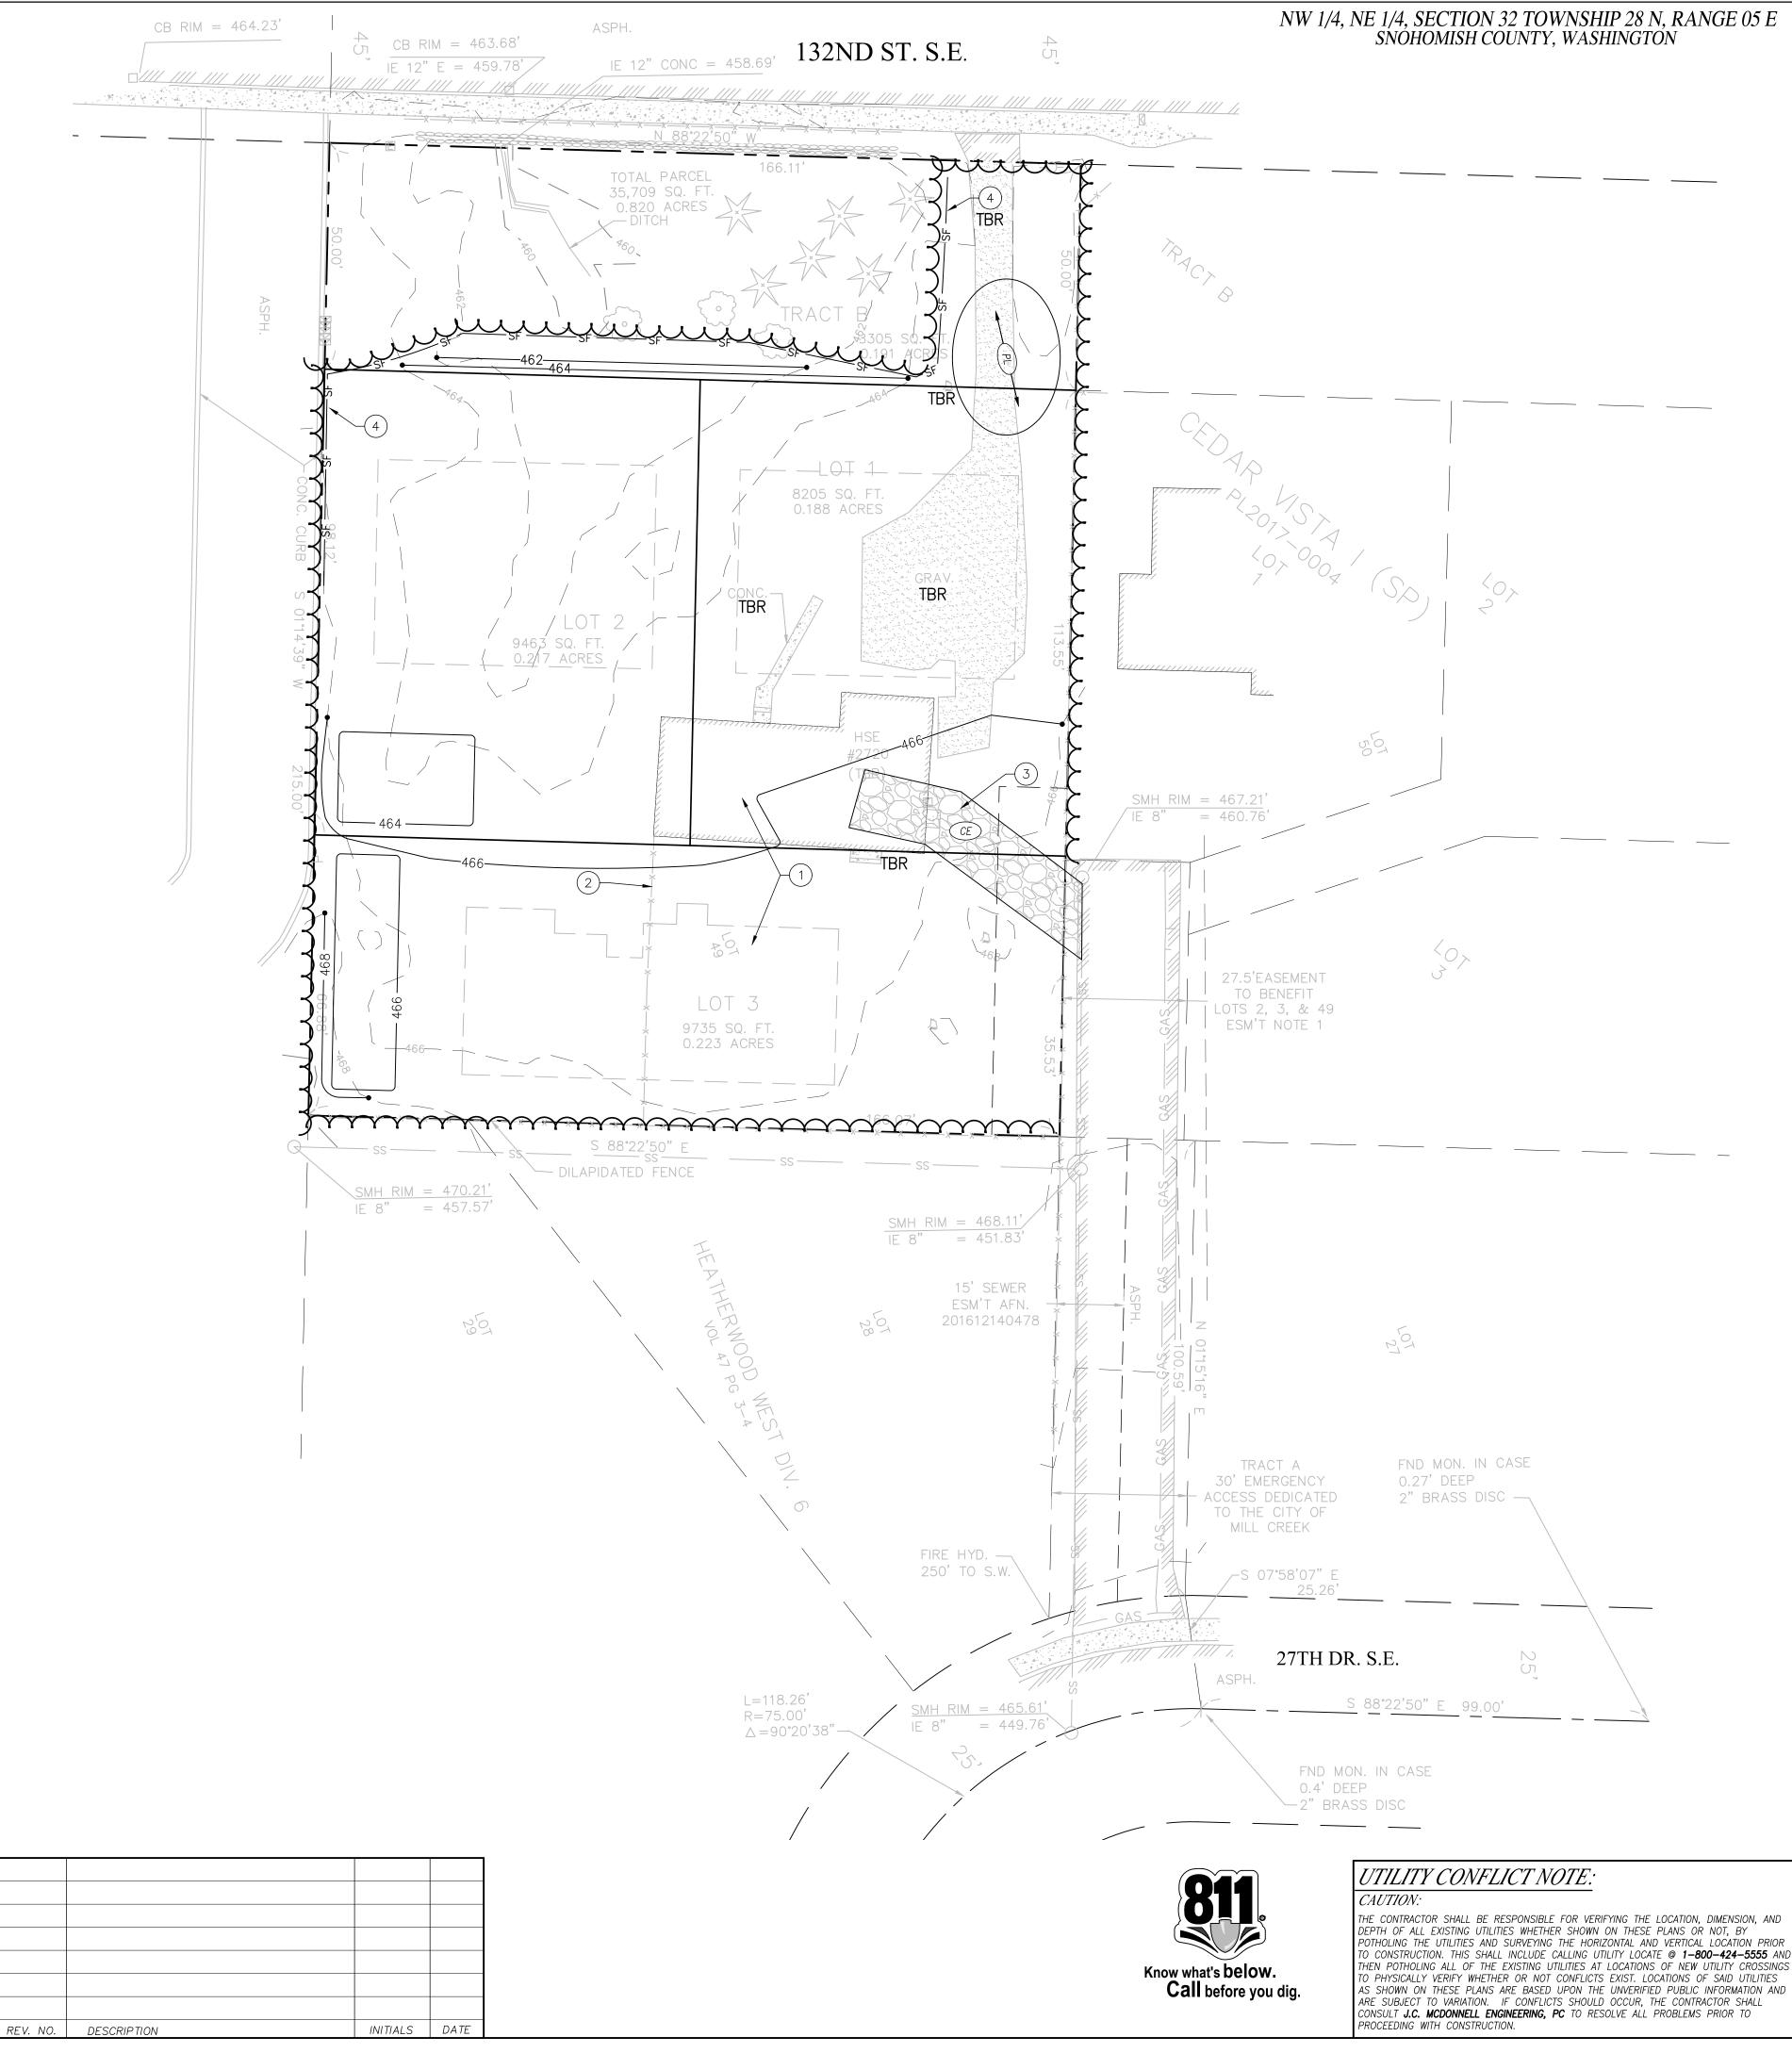

NW 1/4, NE 1/4, SECTION 32 TOWNSHIP 28 N, RANGE 05 E SNOHOMISH COUNTY, WASHINGTON

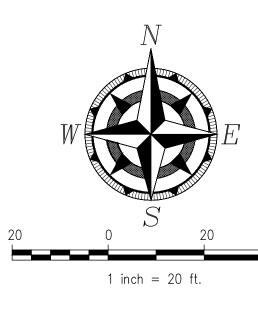


REMOVAL/DEMOLITION & TESC NOTES

- (1) ON-SITE STRUCTURE TO BE MOVED
- (2) REMOVE EXISTING FENCES
- (3) INSTALL STABILIZED CONSTRUCTION ENTRANCE
- (4) 170 LF SILT FENCE

T.E.S.C. LEGEND

| | CLEARING LIMITS – BM |
|-------|--|
| CE | TEMPORARY CONSTRUC |
| SF | SILT FENCE - BMP C2 |
| PL >> | PLASTIC COVER – BMF |
| 466 | PROPOSED CONTOUR |
| SF | SILT FENCE – BMP C2 PLASTIC COVER – BMF |

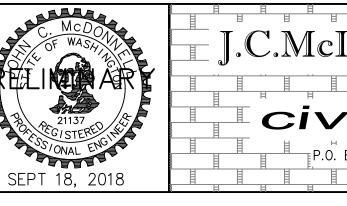

CONSTRUCTION SEQUENCE

- 1. PRIOR TO ANY CONSTRUCTION ACTIVITY, THE CONTRACTOR SHALL SCHEDULE AND ATTEND A PRE-CONSTRUCTION CONFERENCE WITH THE CITY INSPECTION UNIT.
- 2. INSTALL ROCK CONSTRUCTION ENTRANCE.
- 3. STOCKPILE ALL EROSION MATERIALS ON SITE.
- 4. FLAG CLEARING LIMITS.
- 5. ARRANGE FOR CITY TO INSPECT AND APPROVE CLEARING LIMIT FLAGGING PRIOR TO CLEARING.
- 6. INSTALL FILTER FABRIC FENCE AND PROTECTION FENCE AS SHOWN.
- 7. CLEARING, GRUBBING, DEMOLITION, ROUGH GRADING OF SITE.
- 8. INSTALL ALL BURIED UTILITIES.
- 9. INSTALL ALL OTHER UTILITIES & FINE GRADE ROADS.
- 10. INSTALL FINAL PAVING.
- 12. ON COMPLETION OF BUILDING STABILIZE UNPAVED AREAS WITH LANDSCAPING OR HYDROSEEDING AS PERMANENT COVER.
- 13. REMOVE REMAINING TESC FACILITIES FOLLOWING SITE STABILIZATION.

BMP C233 & C103

UCTION ENTRANCE – BMP C105


C233

BMP C123

| | 00747900004900 2720 - 132ND ST SE MILL CREEK, WA 98012 |
|--|--|
| DONNELL ENGINEERING, PC | PRELIMINARY CLEARING, GRADING AND TESC PLAN KAZZIEP SHORT PLAT NE1/4 SECTION 32TOWNSHIP 28 N, RANGE 05 E SNOHOMISH COUNTY, WASHINGTON |
| | DRAWN BY DATE REV. BY DATE PROJECT MANAGER SCALE <i>TJW 09/18/2018 J.C. McDonnell</i> AS SHOWN |
| OX 13199, MILL CREEK, WASHINGTON TEL: (425) 744–0916 | DRAWING FILE NAMECHK. BYF.B. NO.JOB NO.SHT. NO.6063-Filbert Road 5-Unit.dwgJCM6063C3 OF 4 |


TAX ACCOUNT NO.(S):

SITE ADDRESS:

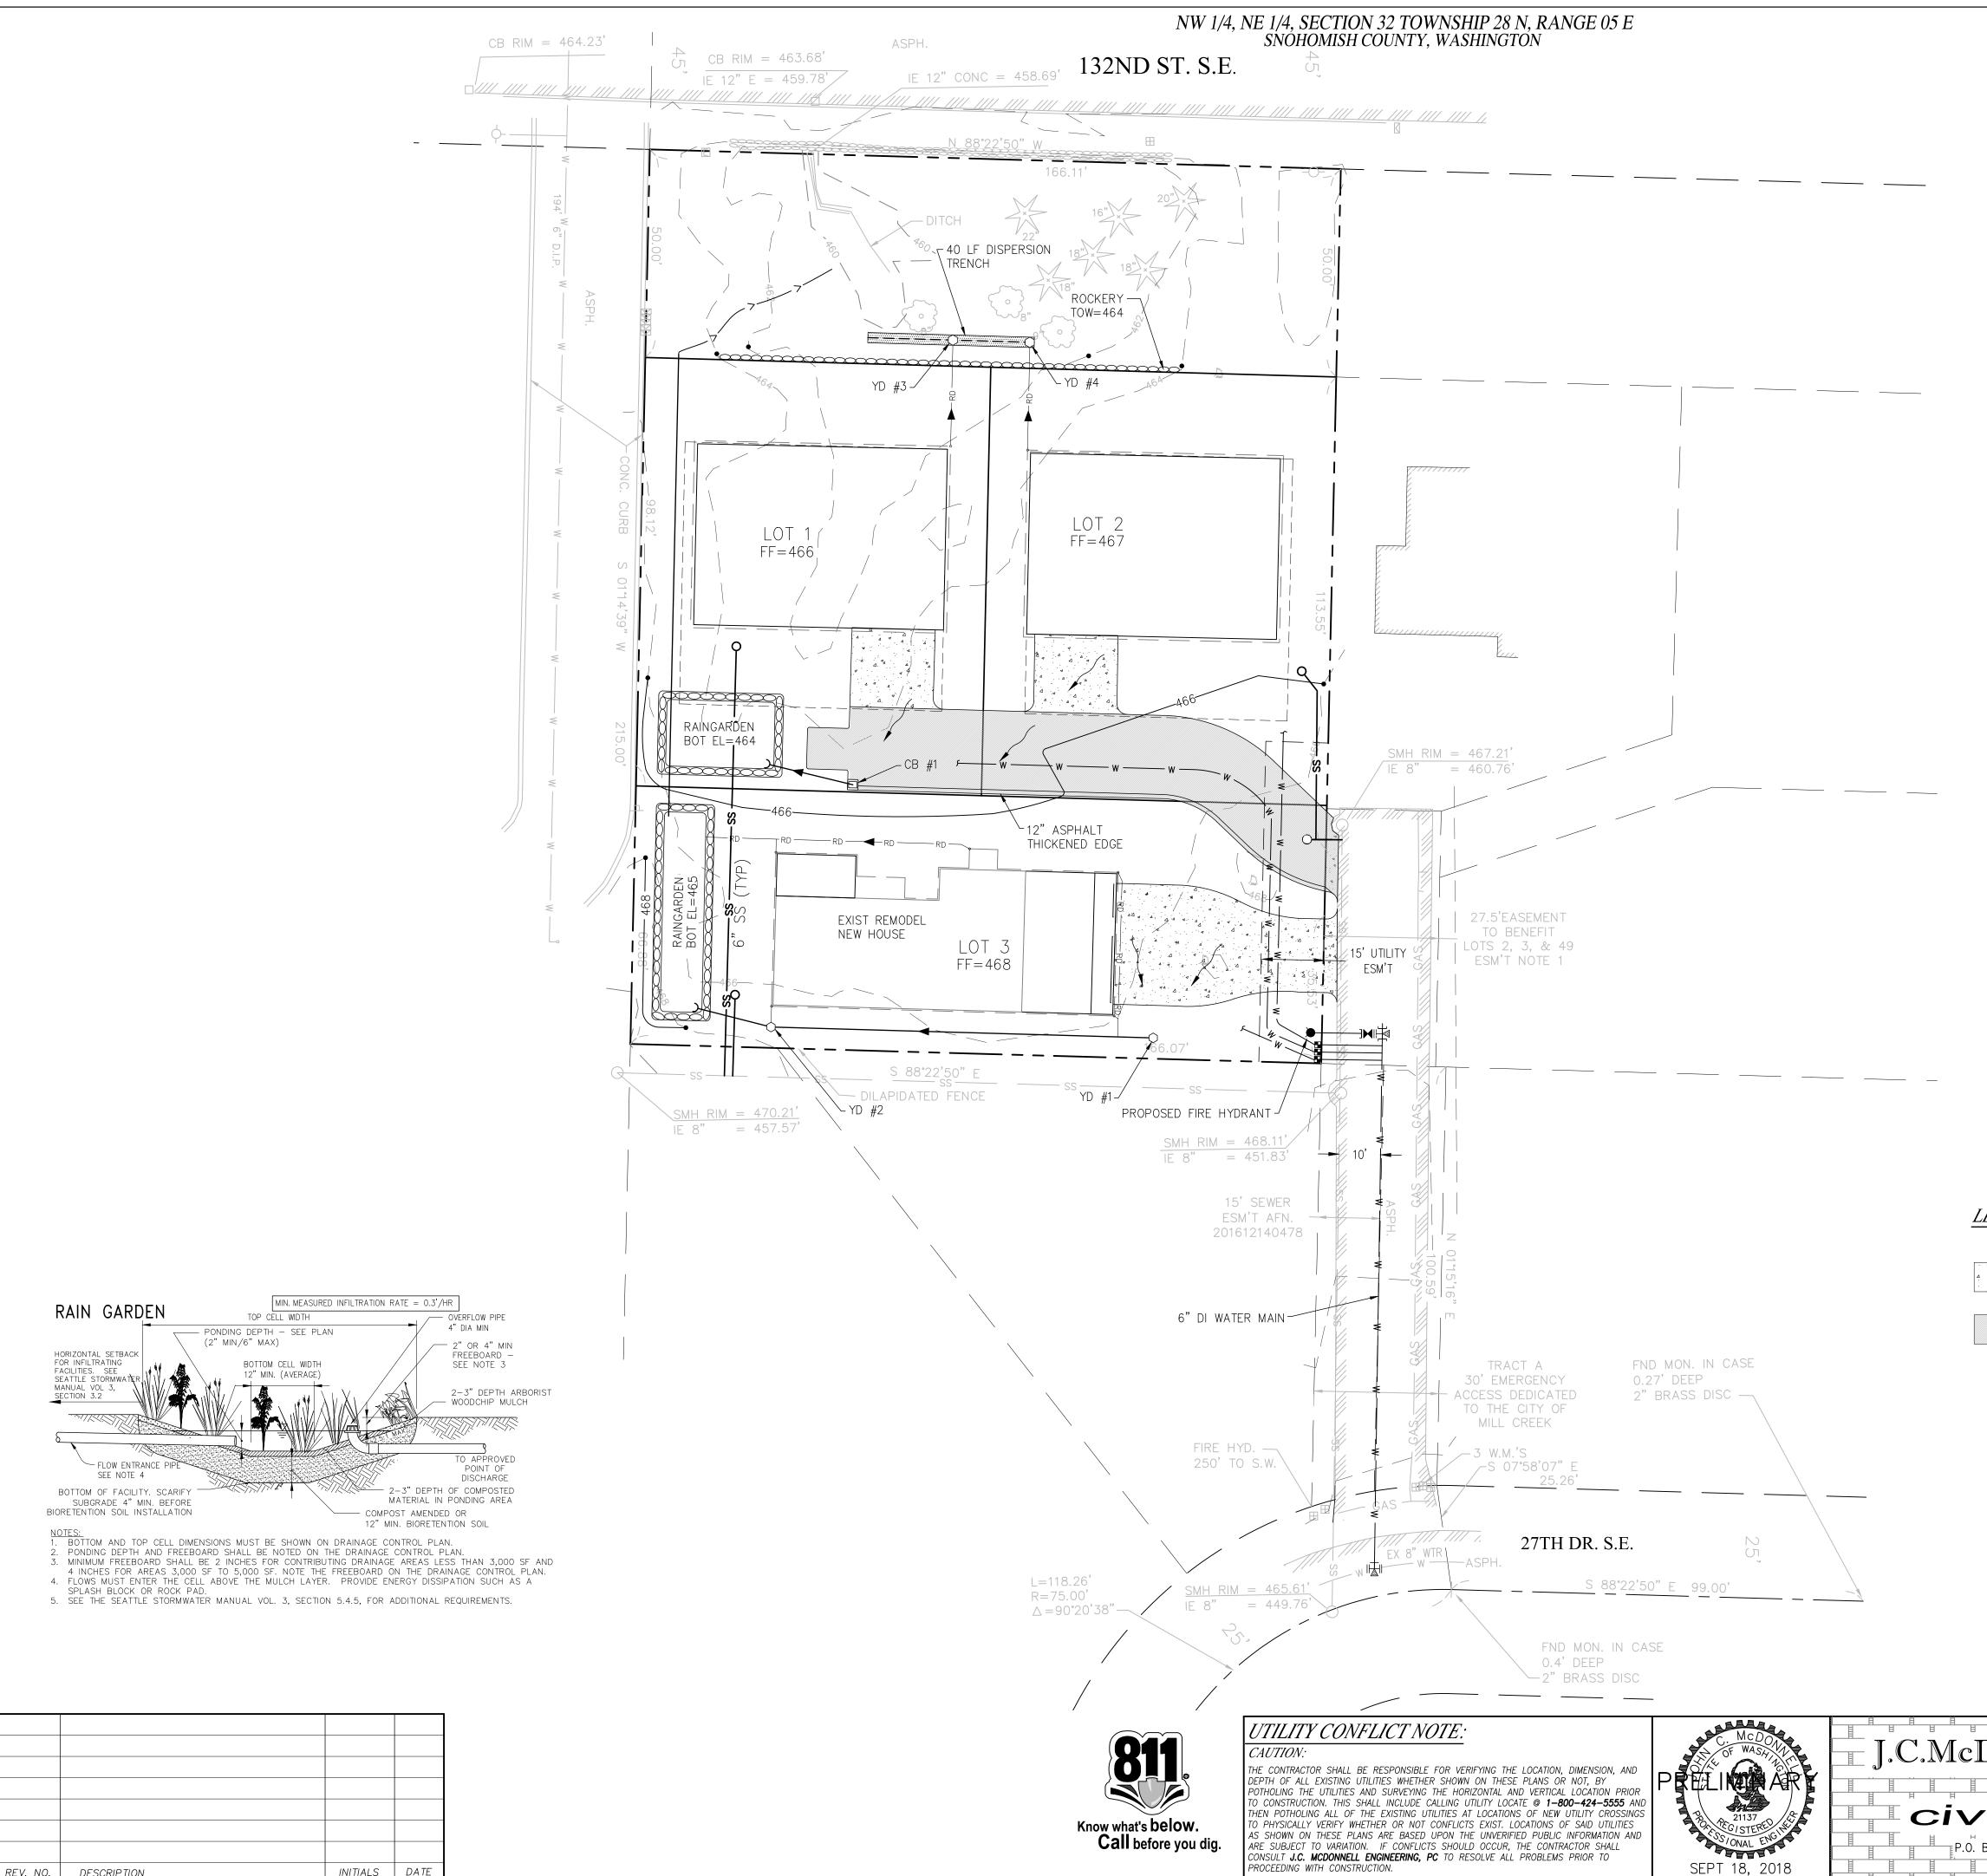

REV. NO. DESCRIPTION

INITIALS DATE

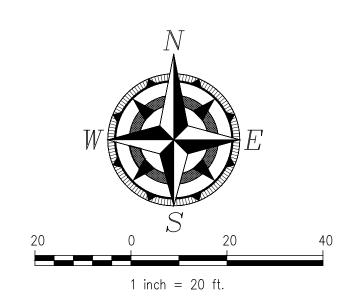

ENGINEERS GRADING NOTES:

- 1. THE DRAINAGE SYSTEM SHALL BE INSTALLED IN ACCORDANCE WITH THE APPROVED PLAN. APPROVAL BY THE COUNTY BUILDING INSPECTOR OF THE DRAINAGE SYSTEM IS REQUIRED PRIOR TO THE FRAMING INSPECTION.
- 2. AREAS TO RECEIVE FILL SHALL BE CLEARED OF ALL VEGETATION AND DELETERIOUS MATTER.
- 3. ALL FILL MATERIALS USED BE FREE OF VEGETATION AND DELETERIOUS MATTER AND SHALL NOT CONTAIN ROCKS GREATER THEN 6" IN DIAMETER.
- 4. STRUCTURAL FILLS SHALL BE PLACED IN 8" TO 10" THICK LOOSE HORIZONTAL LIFTS AND SPREAD UNIFORMLY.
- 5. AFTER EACH LIFT HAS BEEN SPREAD EVENLY, IT SHALL BE COMPACTED TO 95% OF MAXIMUM DENSITY (MODIFIED PROCTOR).
- 6. THE SURFACE OF ALL SLOPES SHALL BE COMPACTED. THIS MAY BE DONE BY OVER-BUILDING THE SLOPES THEN CUTTING BACK TO FINAL GRADES, OR RUNNING THE COMPACTOR OVER THE SLOPE AS EACH FILL LIFT IS BEING PLACED. ALL SLOPES SHALL BE COMPACTED AT THE END OF EACH WORK DAY.
- 7. FIELD DENSITY TESTS WILL BE MADE BY A QUALIFIED SOILS ENGINEERING FIRM. DENSITY TESTS SHALL BE TAKEN AT OF JUST BELOW THE SURFACE AT THE FREQUENCY AND AT LOCATIONS DETERMINED BY THE SOILS ENGINEERING FIRM WHEN THE TESTS INDICATE THAT THE DENSITY OF ANY LAYER OF FILL OR PORTION THEREOF IS BELOW THE SPECIFIED DENSITY, THE PARTICULAR SECTION SHALL BE REWORKED UNTIL THE REQUIRED DENSITY HAS BEEN OBTAINED.
- 8. ALL CUT OR FILL SLOPES MUST BE GRADED TO NO STEEPER THAN A 2 HORIZONTAL TO A 1 VERTICAL SLOPE, (2:1). IF SLOPES ARE TO STAND STEEPER THAN 2:1, A GEOTECHNICAL REPORT PREPARED AND STAMPED BY A LICENSED GEOTECHNICAL ENGINEER MUST BE SUBMITTED CERTIFYING THAT THE SLOPE WILL BE ABLE TO STAND WITHOUT FAILURE, OR A DETAILED DESIGN FOR A ROCK OR CONCRETE RETAINING WALL MUST BE STAMPED BY A LICENSED WA STATE CIVIL ENGINEER AND SUBMITTED FOR REVIEW.
- 9. ALL SITE WORK MUST CAREFULLY FOLLOW THE RECOMMENDATIONS OF THE GEOTECHNICAL REPORT. THE REPORT WAS PREPARED BY COBALT GEOTECHNICAL DATED JUNE 18, 2018. ALL EXCAVATIONS TO BE INSPECTED BY THE ENGINEER TO VERIFY SUBSOIL CONDITIONS.
- 10. TRENCH BACKFILL OF NEW UTILITIES AND STORM DRAINAGE FACILITIES SHALL BE COMPACTED TO 95% MAXIMUM DENSITY (MODIFIED PROCTOR) UNDER ROADWAYS AND 90% MAXIMUM DENSITY(MODIFIED PROCTOR) OFF ROADWAYS, AS SPECIFIED IN SECTION 2-03.3 (14)C COMPACTING EARTH EMBANKMENTS METHOD B.

LEGEND

| . д . д д . д , д | PROPOSED CONCRETE |
|-----------------------------|----------------------|
| | PROPOSED ASPHALT |
| | PROPOSED CATCH BASIN |
| Ô | PROPOSED YARD DRAIN |

| | TAX ACCOUNT NO.(S): SITE ADDRESS: |
|---|---|
| | 00747900004900 2720 - 132ND ST SE MILL CREEK, WA 98012 |
| | |
| DONNELL | PRELIMINARY DRAINAGE AND UTILITY PLAN KAZZIEP SHORT PLAT |
| $\mathbf{}$ ENGINEERING, PC $\mathbf{}$ | NE1/4 SECTION 32TOWNSHIP 28 N, RANGE 05 E SNOHOMISH COUNTY, WASHINGTON |
| il engineers 🔚 | DRAWN BY DATE REV. BY DATE PROJECT MANAGER SCALE |
| н н н н н н н Ц Н | TJW 09/18/2018 J.C. McDonnell AS SHOWN |
| OX 13199, MILL CREEK, WASHINGTON TEL:(425) 744–0916 | DRAWING FILE NAME CHK. BY F.B. NO. JOB NO. SHT. NO. |
| | 6063-Filbert Road 5-Unit.dwg JCM 6063 C4 OF 4 |